

SITE PLAN - NOT TO SCALE



LEGEND

DB DISTRIBUTION BOARD

R CASE

PAYOUT TERMINAL

ST SINGLE OPERATING TERMINAL

D DUAL OPERATING TERMINAL

SKY DECODER

T TELSTRA

D	Revised for Quotation	23/10/20
С	Issue for Quotation	21/10/20
В	Revision to Floor Plan	13/10/20
Α	Preliminary drawings for Approval	09/10/20

Revision Schedule

Contractor to verify all dimensions on site before commencing work. RWWA is to be notified of any discrepancies and setting out of work, for resolution. Copyright of designs shown hereon is retained by this office Authority is required for any reproduction.



RACING AND WAGERING WESTERN AUSTRALIA

PR51 RACEWALL ROLLOUT SL1 AGENCY178 Broome, Shop 22 Prime West Broome Boulevard, 106 Frederick Street, Djugun WA 6725

RDC - DONNA MAGUIRE Tel: 08 9445 5321 Mob:0417 951 824 Email: donna.maguire@rwwa.com.au


Chris Mealor Property Services Coordinator Tel: 0438 948 501 Email: chris.mealor@rwwa.com.au

14 HASLER ROAD OSBORNE PARK WA 6017

DRAWING:

Site Layout

					j
DATE:	09/10/20	DWG			
DRAWN:	S.Salmon	PR51-178-A001			
CHECKED:	СМ	0	А3	SCALE	1 : 50

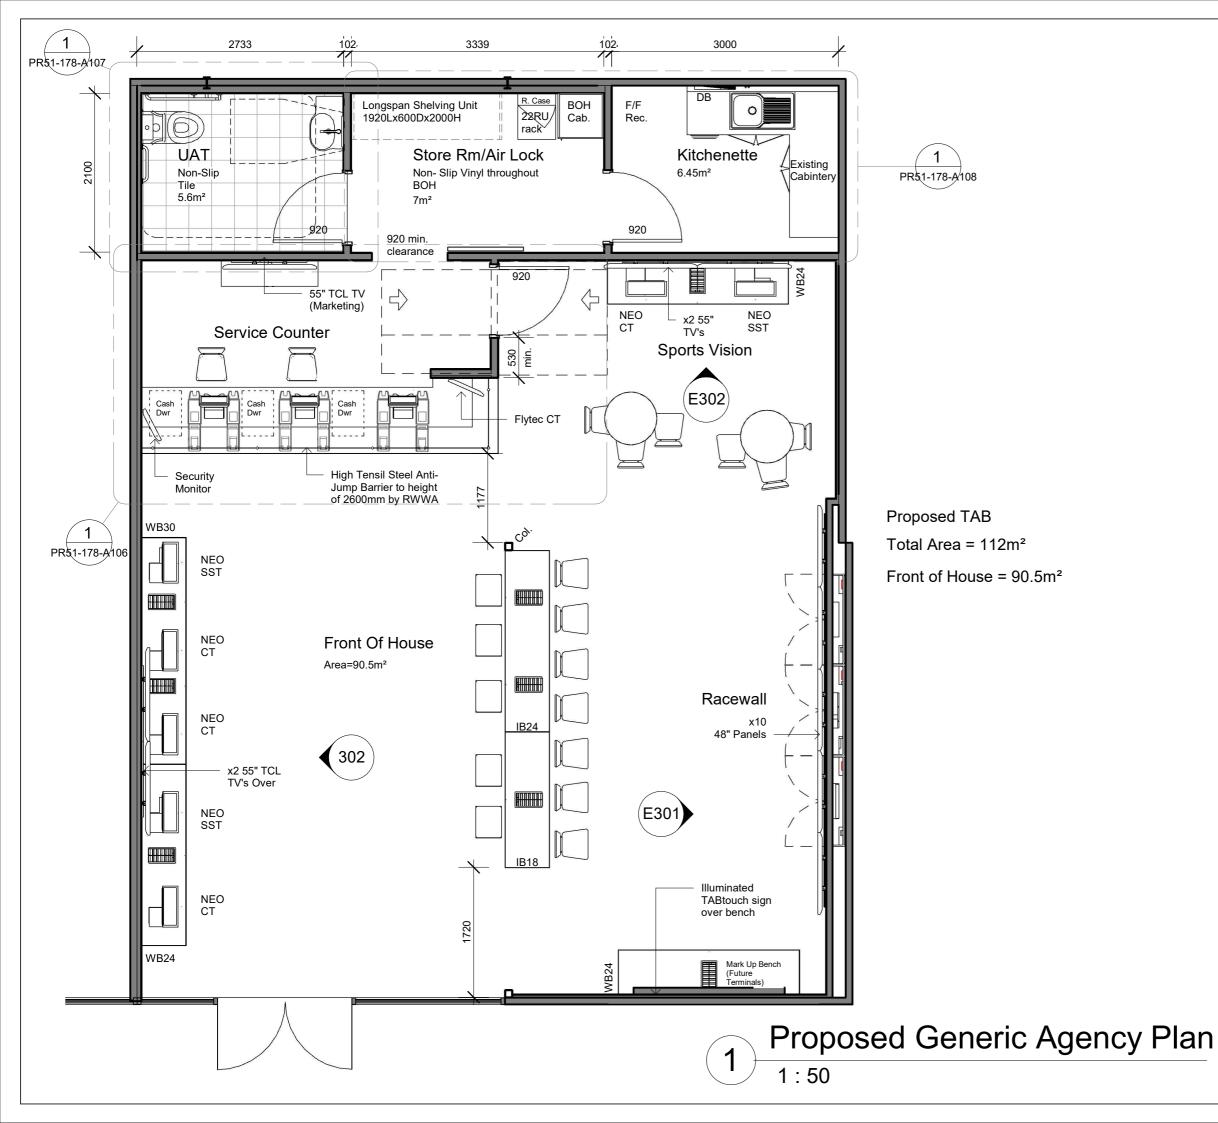

NOTES

- Refer to PR51 RWWA standard joinery drawing package for joinery details.
- 2. Refer to dwgs A200, A201 & A202 for elevation details.
- 3. Refer to finishes schedule on RWWA dwg A400 & A401 for laminate finishes.
- 4. Media player locations to be confirmed.
- Refer to RWWA dwgs A301, A302 & A303 for locations of power, data & audio visual requirements.
- Electrical/audio visual contractor to refer to RWWA standard electrical drawing PR51-01-03 for details of data cabling, wiring diagram and the like.
- Indicative location of Racewall Master Switch. Final position to be determined.
- For each DOT Electrical contractor to provide (x1) quad data outlet and (x2) dbl GPO's.
 Electrical contractor to replace existing CAT 5 data outlet at SOT with (x1) triple data outlet and (x1) dbl GPO.
- All Electrical Works to comply with NCC Part J6 and AS/NZS 3000.
- 10. Latching devices to exit doors to comply with NCC D2.21
- All new glass assemblies (if applicable) to be in accordance with AS 1288 & AS 2047.
- 12. Location of NVR security monitor/CIT on flytec bracket to be confrimed with RDC/Agent.

D	Revised for Quotation	23/10/20
С	Issue for Quotation	21/10/20
В	Revision to Floor Plan	13/10/20
Α	Preliminary drawings for	09/10/20

Revision Schedule

Contractor to verify all dimensions on site before commencing work. RWWA is to be notified of any discrepancies and setting out of work, for resolution. Copyright of designs shown hereon is retained by this office Authority is required for any reproduction.



RACING AND WAGERING WESTERN AUSTRALIA

PR51 RACEWALL ROLLOUT SL1 AGENCY178 Broome, Shop 22 Prime West Broome Boulevard, 106 Frederick Street, Djugun WA 6725

RDC - DONNA MAGUIRE Tel: 08 9445 5321 Mob:0417 951 824 Email: donna.maguire@rwwa.com.au

Chris Mealor
Property Services Coordinator
Tel: 0438 948 501
Email: chris.mealor@rwwa.com.au


14 HASLER ROAD OSBORNE PARK WA 6017

DRAWING:

Generic Agency Layout

DATE: 09/10/20 DWG
PR51-178-A100

CHECKED: CM © A3 SCALE 1:50

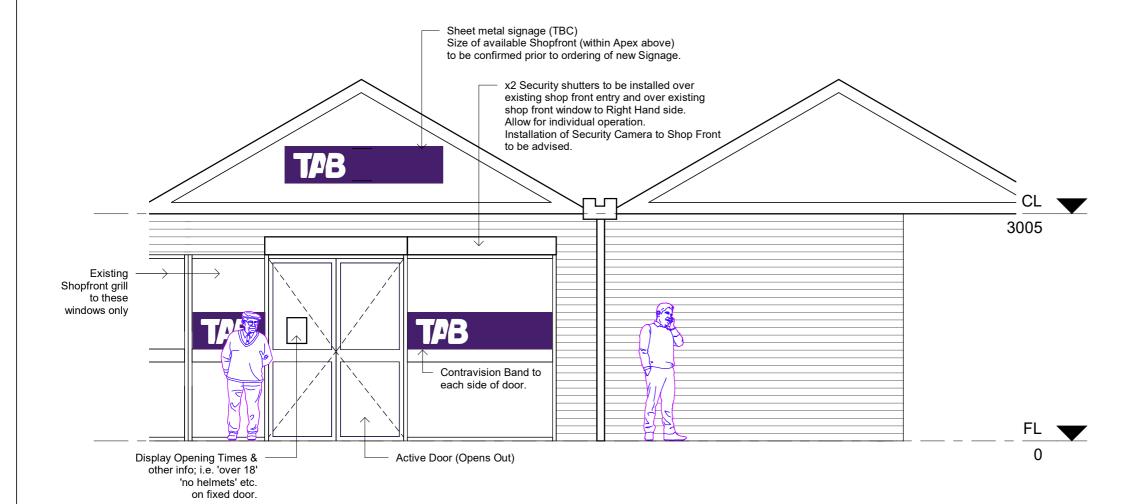

Proposed Shop Front Signage

D	Revised for Quotation	23/10/20
С	Issue for Quotation	21/10/20
В	Revision to Floor Plan	13/10/20
	Preliminary drawings for Approval	09/10/20

Revision Schedule

Contractor to verify all dimensions on site before commencing work. RWWA is to be notified of any discrepancies and setting out of work, for resolution. Copyright of designs shown hereon is retained by this office. Authority is required for any reproduction.



RACING AND WAGERING WESTERN AUSTRALIA

PR51 RACEWALL ROLLOUT SL1 AGENCY178 Broome, Shop 22 Prime West Broome Boulevard, 106 Frederick Street, Djugun WA 6725

RDC - DONNA MAGUIRE Tel: 08 9445 5321 Mob:0417 951 824 Email: donna.maguire@rwwa.com.au

Chris Mealor **Property Services Coordinator** Tel: 0438 948 501 Email: chris.mealor@rwwa.com.au 14 HASLER ROAD OSBORNE PARK

Property Services Coordinator Tel: 0438 948 501 Email: chris.mealor@rwwa.com.au OSBORNE PARk WA 6017			PARK	Μ		
DRAWING: Shop Front Elevation					2:15:35	
DATE:	09/10/20	DWG		_		
DRAWN:	S.Salmon	PR51-178-A109			3/10/2020	
CHECKED:	DM/CM	©	А3	SCALE	1 : 50	23/1
·		,				